


Site Boundary

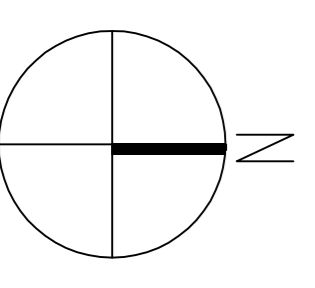

NOTES

| REVISION | DATE | DESCRIPTION | BY | CLIENT |
|----------|----------|----------------|-----|--------|
| 7 | 25/07/10 | PLANNING ISSUE | SAP | |
| A | 29/07/10 | PLANNING ISSUE | SAP | |

STUDIO PLANNING
 LONDON
 HAMM
 MANCHESTER
 GLASGOW



SAP ARCHITECTS
 ARCHITECTS
 100, 101, 102, 103, 104, 105
 WICKERS BAY
 LONDON
 W12 8BA
 T +44 (0) 20 7531 8877
 F +44 (0) 20 7531 4477
 E info@saparchitects.com
 W www.saparchitects.com

EXISTING SITE PLAN

SCALE 1:500
 SHEET 01 OF 01
 PROJECT NO. 3033
 DRAWING NO. (08) 005
 DATE JAN 10
 CHECKED BY JHP
 DRAWN BY JHP
 REVISION A

THIS DRAWING IS TO BE USED IN CONNECTION WITH THE PLANNING APPLICATION ONLY. IT IS NOT TO BE USED FOR ANY OTHER PURPOSE. THE CLIENT ACCEPTS FULL RESPONSIBILITY FOR THE ACCURACY OF THE INFORMATION PROVIDED TO THE ARCHITECTS AND FOR THE CONTENTS OF THIS DRAWING. THE ARCHITECTS ACCEPTS FULL RESPONSIBILITY FOR THE ACCURACY OF THE INFORMATION PROVIDED TO THE CLIENT AND FOR THE CONTENTS OF THIS DRAWING.

Refer to Plan Extract



Notes



1. This document should not be relied on or used in circumstances other than those for which it was prepared and for which Chris Blandford Associates was commissioned. Chris Blandford Associates accepts no responsibility for this document to any other party other than the person by whom it was commissioned.
2. Based upon the Ordnance Survey Map with the permission of the controller of H.M. Stationery Office. © Crown Copyright Licence number

KEY

 PROJECT SITE BOUNDARY



Plan Extract

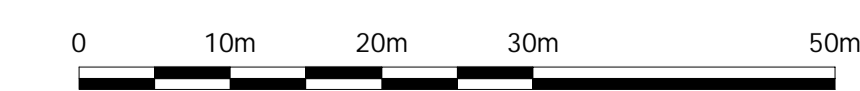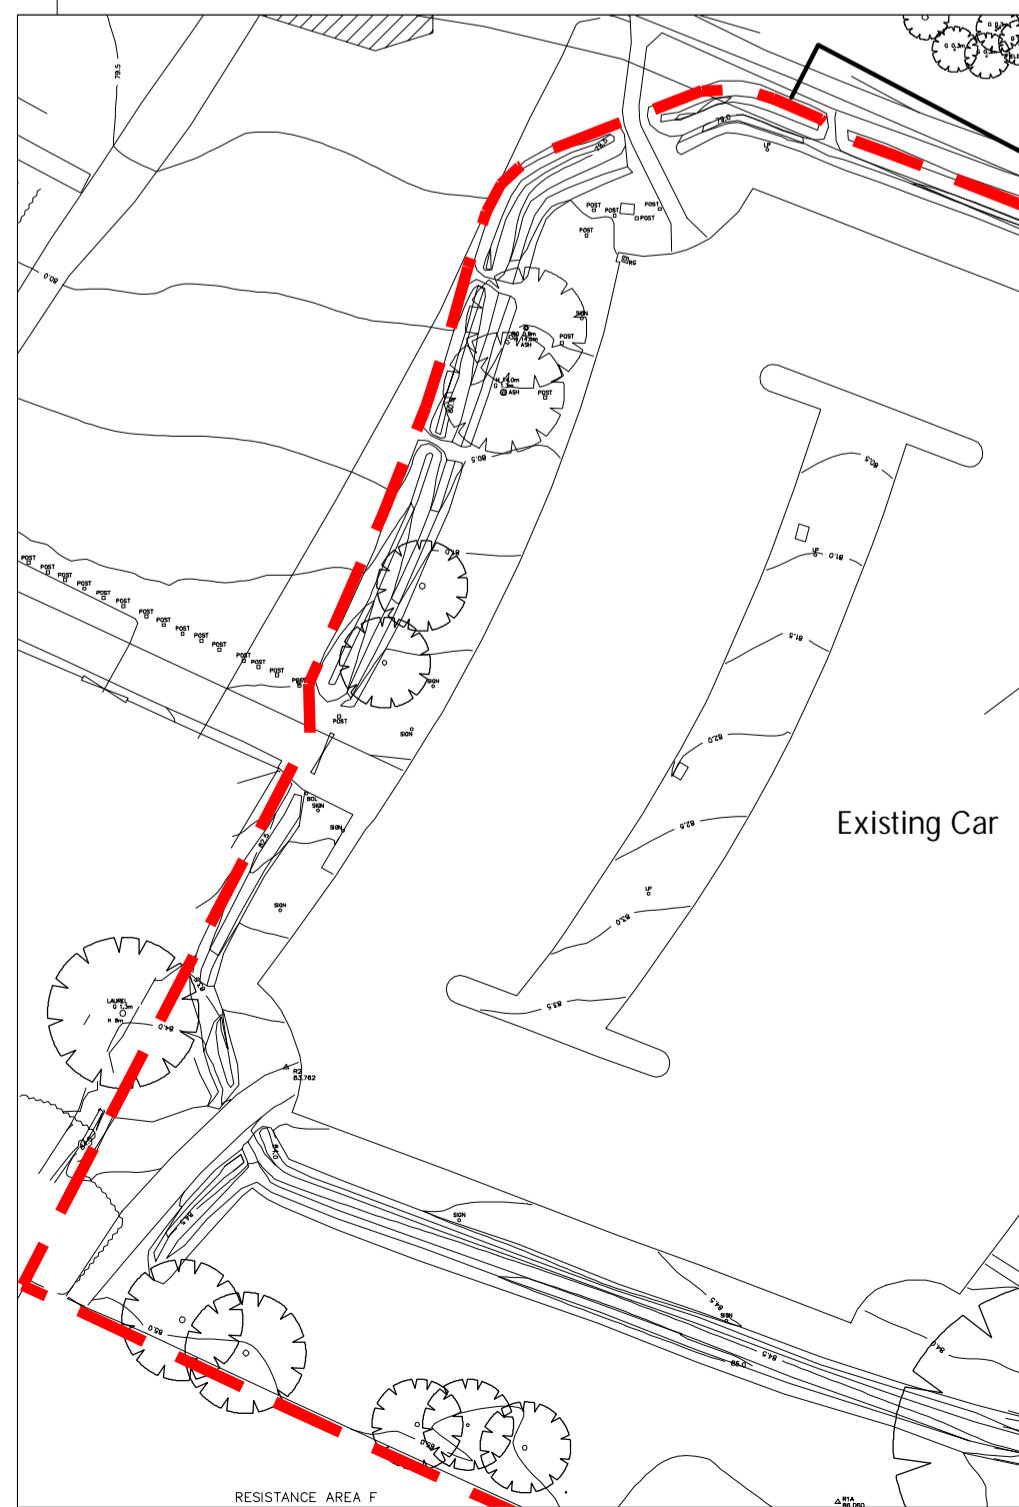

| Rev | Description | Date | Initials |
|-----|--------------|----------|----------|
| A | FOR PLANNING | 22/01/10 | SL |

CHRIS BLANDFORD ASSOCIATES
environment landscape planning 

Swan Court 9, Tanner Street, London SE1 3LE T 020 7089 6480
F 020 7089 9260 E mail@cba.uk.net W www.cba.uk.net

Project Title
Westminster Lodge - St Albans
Stage D

Drawing Title
Existing Site Plan

Scale @ A1
1:500

Drawn
DWE

Approved
DWE

Date
JAN 2010

Drawing number
50017801_GA01

Revision
A